## DRAWING NOTES


- 1. ALL DIMENSIONS ARE TO FACE OF WOOD STUD OR TO CENTERLINE OF WOOD STUD U.N.O..
- 2. ALL STUDS \*2 KILN DRIED S.P.F. WOOD STUDS UNLESS NOTED OTHERWISE.

## GENERAL CONSTRUCTION NOTES:

- 1. INSTALL R-13 FIBERGLASS BATT INSULATION IN EXTERIOR WALLS AND INSTALL 5/8" GWB TO INTERIOR SIDE.
- 2. INSTALL 5/8" GWB TO BOTH SIDES OF EXISTING INTERIOR STUD WALLS.
- 3. INSTALL 1/2" GWB ON CEILING.
- 4. ALL INTERIOR DOORS ARE TO BE MIN. 13/8" THICK SOLID CORE DOORS...
- 5. REPLACE EXISTING DOORS AND/OR HARDWARE IF DEFECTIVE.
- 6. REMOVE ATTIC ACCESS HATCH AND FRAME OPENING TO ACCEPT GWB.

## CONSTRUCTION NOTES:

- A. NEW 2x4" STUDS @ 16" O.C. W/ 5/8" GWB BOTH SIDES. INSTALL SOUND ATTENUATION BLANKETS AT OWNER'S OPTION.
- B. NEW 2x4" STUDS @ 16" O.C. W/ 5/8" MOISTURE RESISTANT GWB BOTH SIDES.
- C. NEW 2x6" STUDS @ 16" O.C. W/ 5/8" GWB ON DRY SIDE AND 5/8" MOISTURE RESISTANT GWB ON WET SIDE. INSTALL SOUND ATTENUATION BLANKETS.
- D. ALIGN NEW WALL WITH FACE OF OPENING.
- E. ALIGN NEW WALL WITH EXISTING WALL
- F. BILCO ROOF HATCH MODEL #5-20. FLASH TO EXISTING BUILT UP ROOF IN ACCORDANCE WITH THE NRCA ROOFING AND WATERPROOFING MANUAL.
- G. 42"H GUARD RAIL AROUND PERIMITER OF BUILT UP ROOF.
- H. RAMP FLOOR UP TO EXISTING DOOR SILL. SEE ALTERNATE PLAN ON DWG A-1.3 SHOULD TOILET FLOOR NEED TO BE RAISED TO ACCOMODATE PLUMBING.

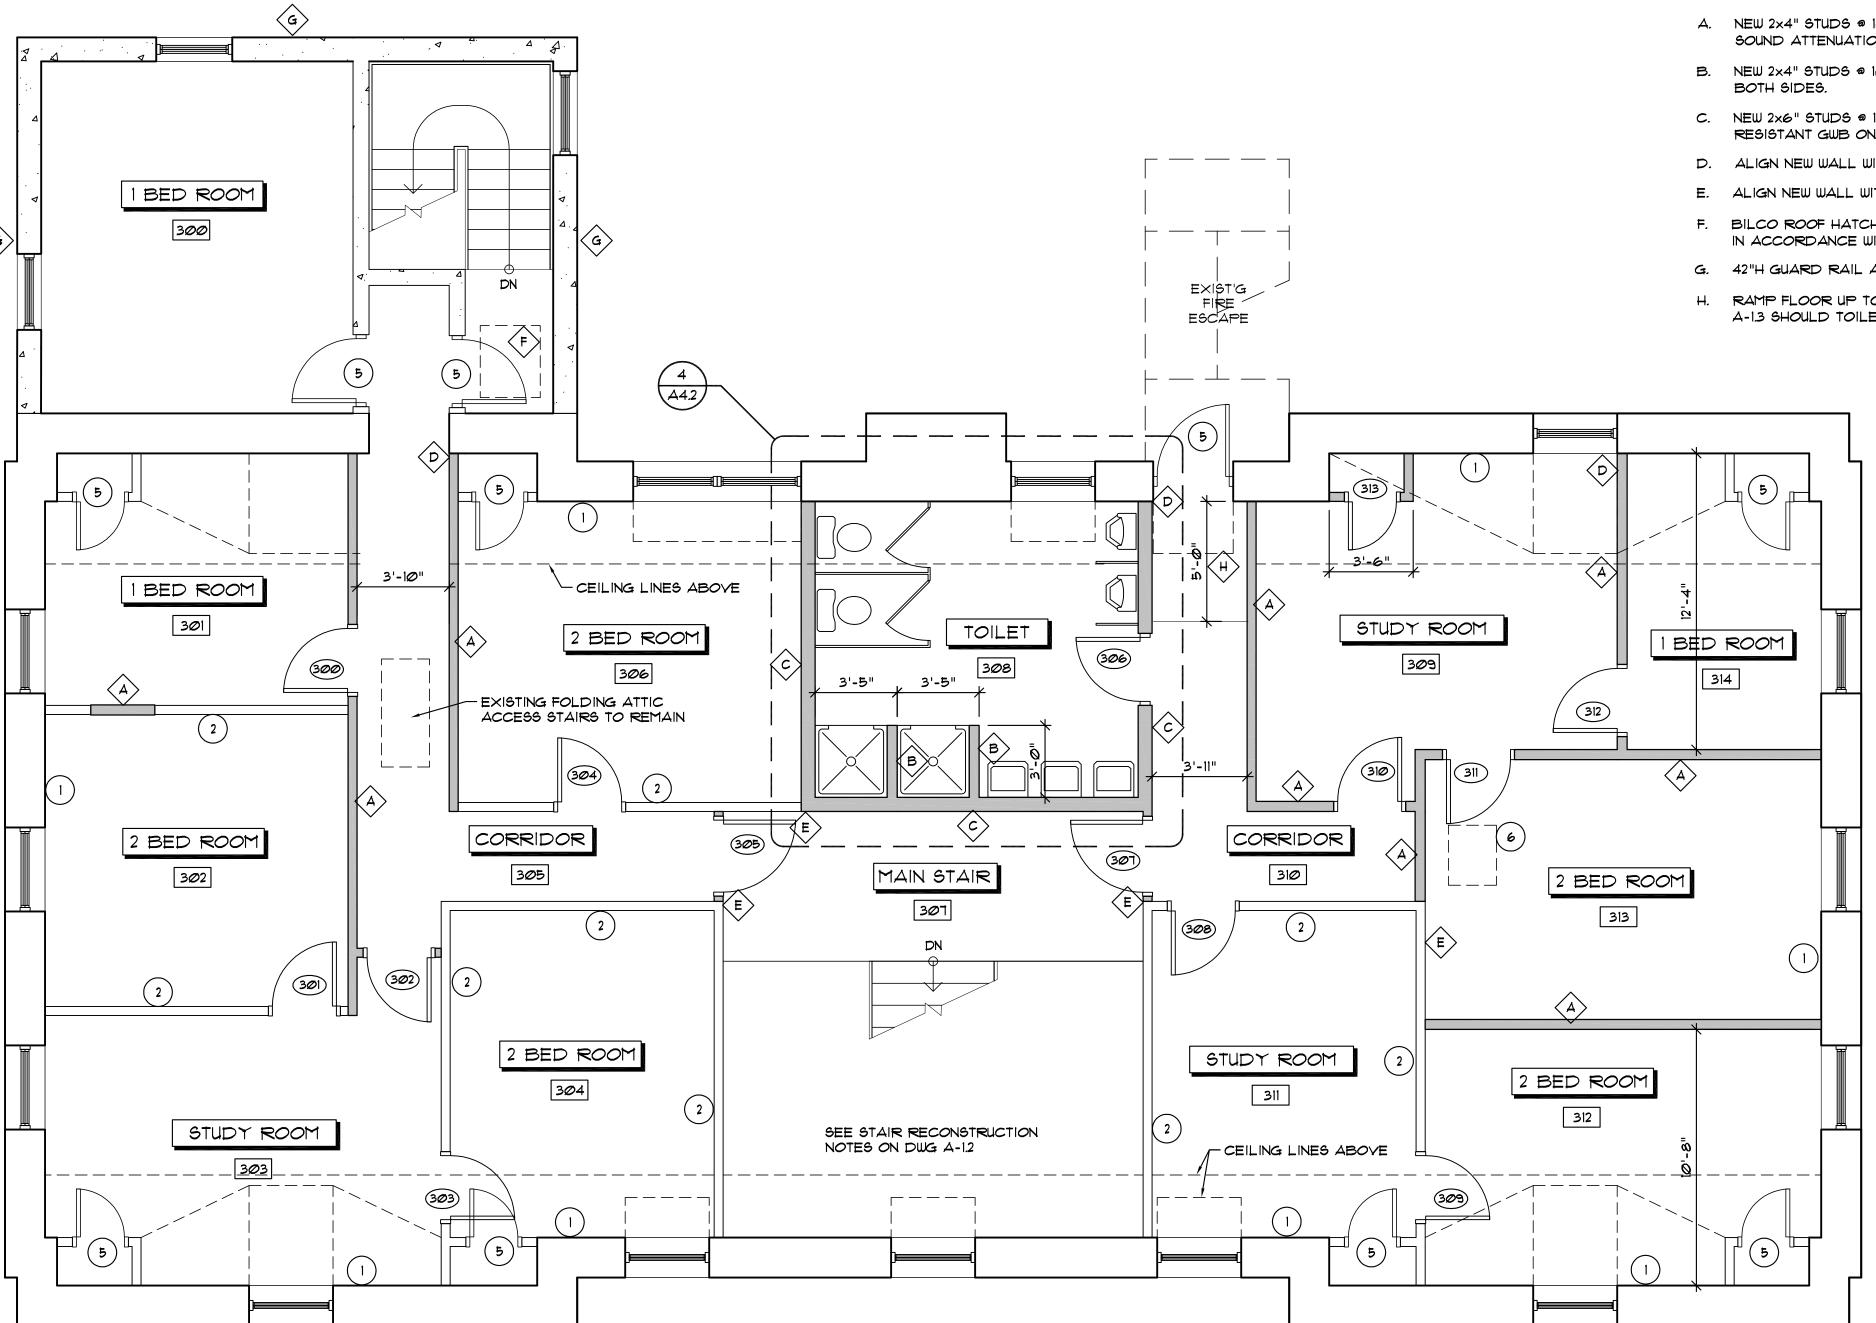

## THIRD FLOOR PLAN

SCALE: 1/4" = 1'-0"

DRAWN BY: CHECKED: SCALE: AS NOTED JOB NUMBER: 0618 REVISIONS: APPROVAL: 4/12/06 OWNER REVIEW: 4/24/06

FINAL REVIEW: 5/22/06

CONSTRUCTION:

DESCRIPTION THIRD FLOOR PLAN

SHEET OF SHEETS