


THIS DRAWING AS AN INSTRUMENT OF SERVICE SHALL NOT BE REPRODUCED, ALTERED OR REUSED IN WHOLE OR IN PART WITHOUT THE WRITTEN PERMISSION OF THE ARCHITECT. ARCHITECTURAL DRAWINGS ARE PROTECTED BY THE U.S. GOVERNMENT COPYRIGHT LEGISLATION/COPYRIGHT 2006, W. BARRY AGNEW ARCHITECT, INC. ALL RIGHTS RESERVED.

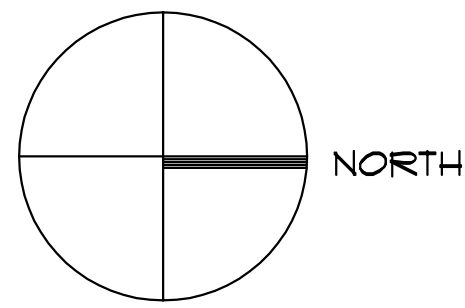

DRAWING NOTES


1. ALL DIMENSIONS ARE TO FACE OF WOOD STUD OR TO CENTERLINE OF WOOD STUD UNO.
2. ALL STUDS - #2 KILN DRIED S.P.F. WOOD STUDS UNLESS NOTED OTHERWISE.

GENERAL CONSTRUCTION NOTES:

1. INSTALL R-13 FIBERGLASS BATT INSULATION IN EXTERIOR WALLS AND INSTALL 5/8" GUB TO INTERIOR SIDE.
2. INSTALL 5/8" GUB TO BOTH SIDES OF EXISTING INTERIOR STUD WALLS.
3. INSTALL 1/2" GUB ON CEILING.
4. ALL INTERIOR DOORS ARE TO BE MIN. 1 3/8" THICK SOLID CORE DOORS.
5. REPLACE EXISTING DOORS AND/OR HARDWARE IF DEFECTIVE.
6. REMOVE ATTIC ACCESS HATCH AND FRAME OPENING TO ACCEPT GUB.


CONSTRUCTION NOTES:

- A. NEW 2x4" STUDS @ 16" O.C. W/ 5/8" GUB BOTH SIDES. INSTALL SOUND ATTENUATION BLANKETS AT OWNER'S OPTION.
- B. NEW 2x4" STUDS @ 16" O.C. W/ 5/8" MOISTURE RESISTANT GUB BOTH SIDES.
- C. NEW 2x6" STUDS @ 16" O.C. W/ 5/8" GUB ON DRY SIDE AND 5/8" MOISTURE RESISTANT GUB ON WET SIDE. INSTALL SOUND ATTENUATION BLANKETS.
- D. ALIGN NEW WALL WITH FACE OF OPENING.
- E. ALIGN NEW WALL WITH EXISTING WALL.
- F. BILCO ROOF HATCH MODEL #S-20. FLASH TO EXISTING BUILT UP ROOF IN ACCORDANCE WITH THE NRCA ROOFING AND WATERPROOFING MANUAL.
- G. 42" H GUARD RAIL AROUND PERIMETER OF BUILT UP ROOF.
- H. RAMP FLOOR UP TO EXISTING DOOR SILL. SEE ALTERNATE PLAN ON DWG A-13 SHOULD TOILET FLOOR NEED TO BE RAISED TO ACCOMMODATE PLUMBING.

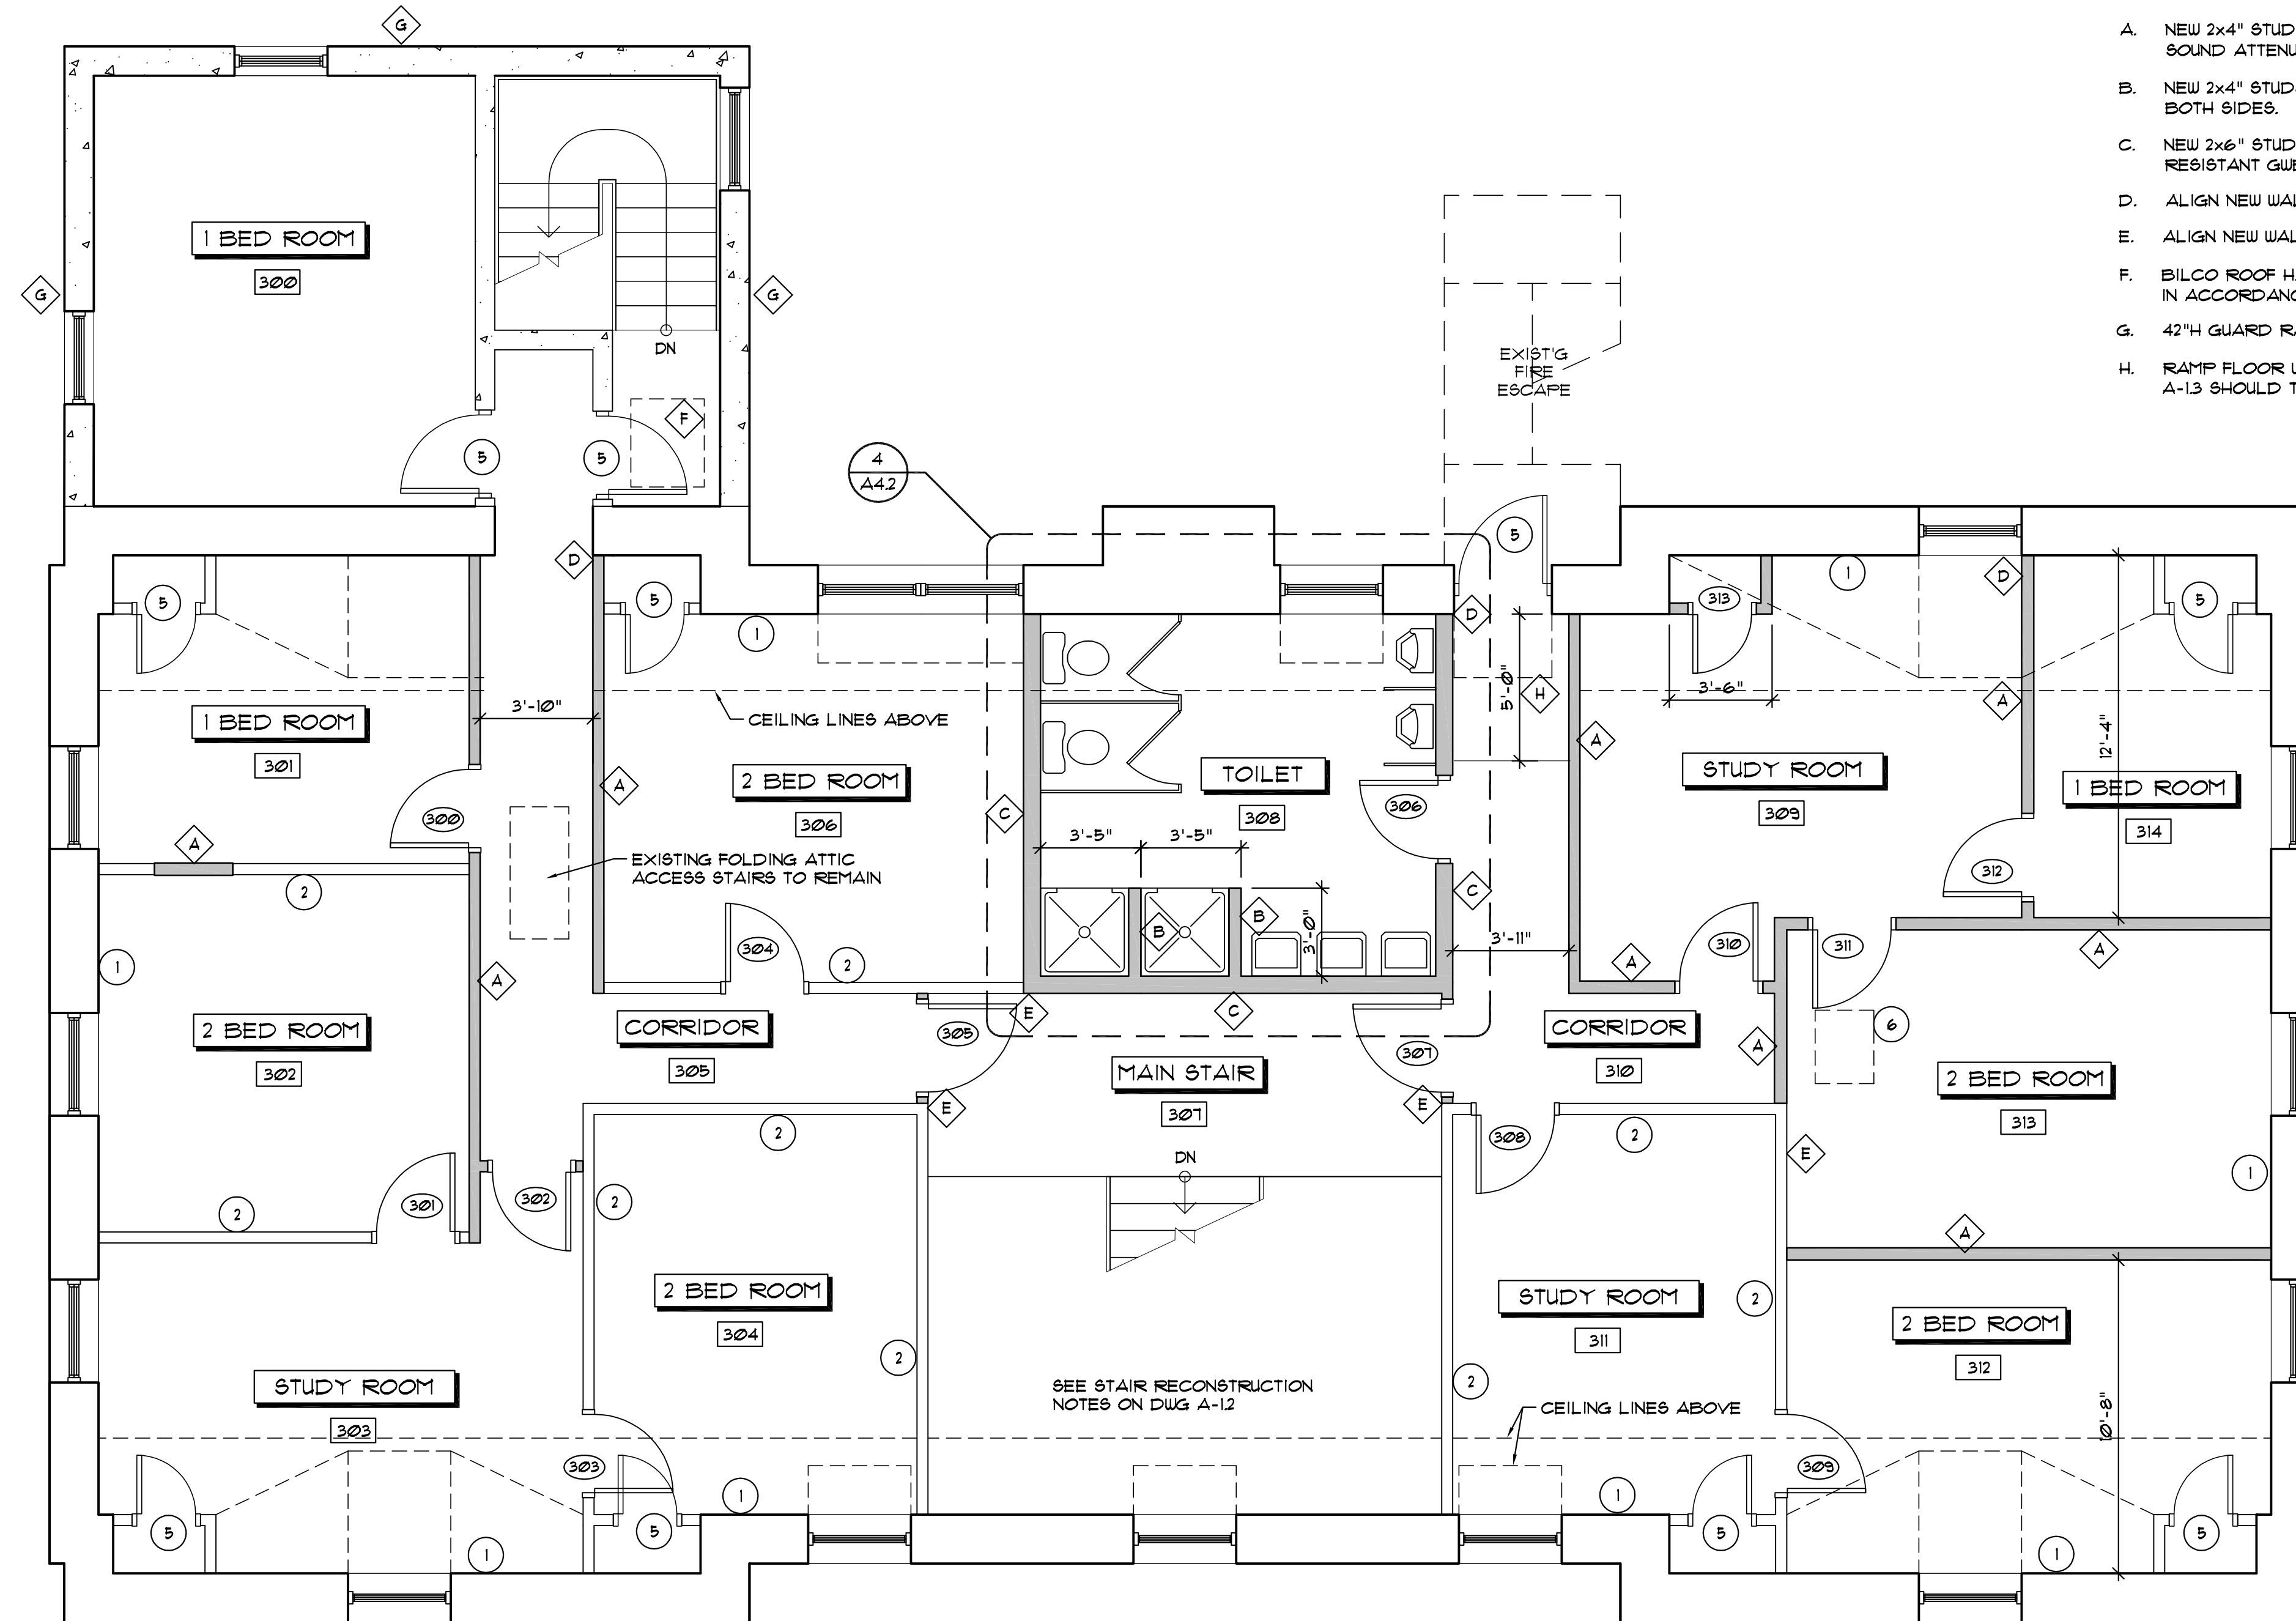

THIRD FLOOR PLAN

SCALE: 1/4" = 1'-0"

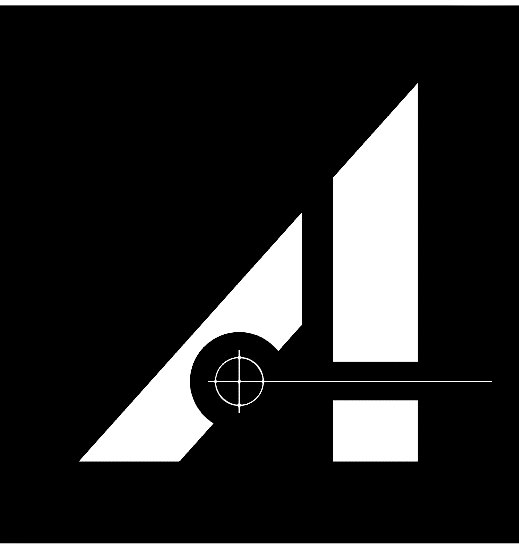

W. BARRY AGNEW ARCHITECT, INC. 121 MANLY STREET, GREENVILLE, SC 29601 864-242-2514

PHI KAPPA PSI FRATERNITY
LAFAYETTE COLLEGE
EASTON, PENNSYLVANIA

DRAWN BY:	EMK
CHECKED:	FJR
SCALE:	AS NOTED
JOB NUMBER:	0618
REVISIONS:	
APPROVAL:	4/12/06
OWNER REVIEW:	4/24/06
FINAL REVIEW:	5/22/06

CONSTRUCTION: -

DESCRIPTION	THIRD FLOOR PLAN
-------------	------------------

SHEET	A = 14
OF SHEETS	